



SEAL

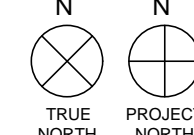

THOMAS G. SMITH | NY: 042383

KEY PLAN

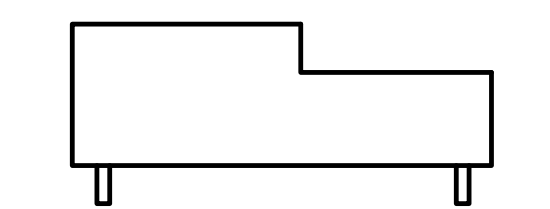


SUBMITTALS		
NO.	DATE	DESCRIPTION
1	4.12.22	100% TILT WALL REVIEW
2	6.9.22	PERMIT
3	7.8.22	FTG STEPS & JOIST SEAT @ A

PROJECT NO.  
AS286-21 | NY131 | 21-154  
DRAWN BY  
CEO

SHEET TITLE  
**TILT WALL  
ELEVATIONS**

SHEET NO.


**T1.7**

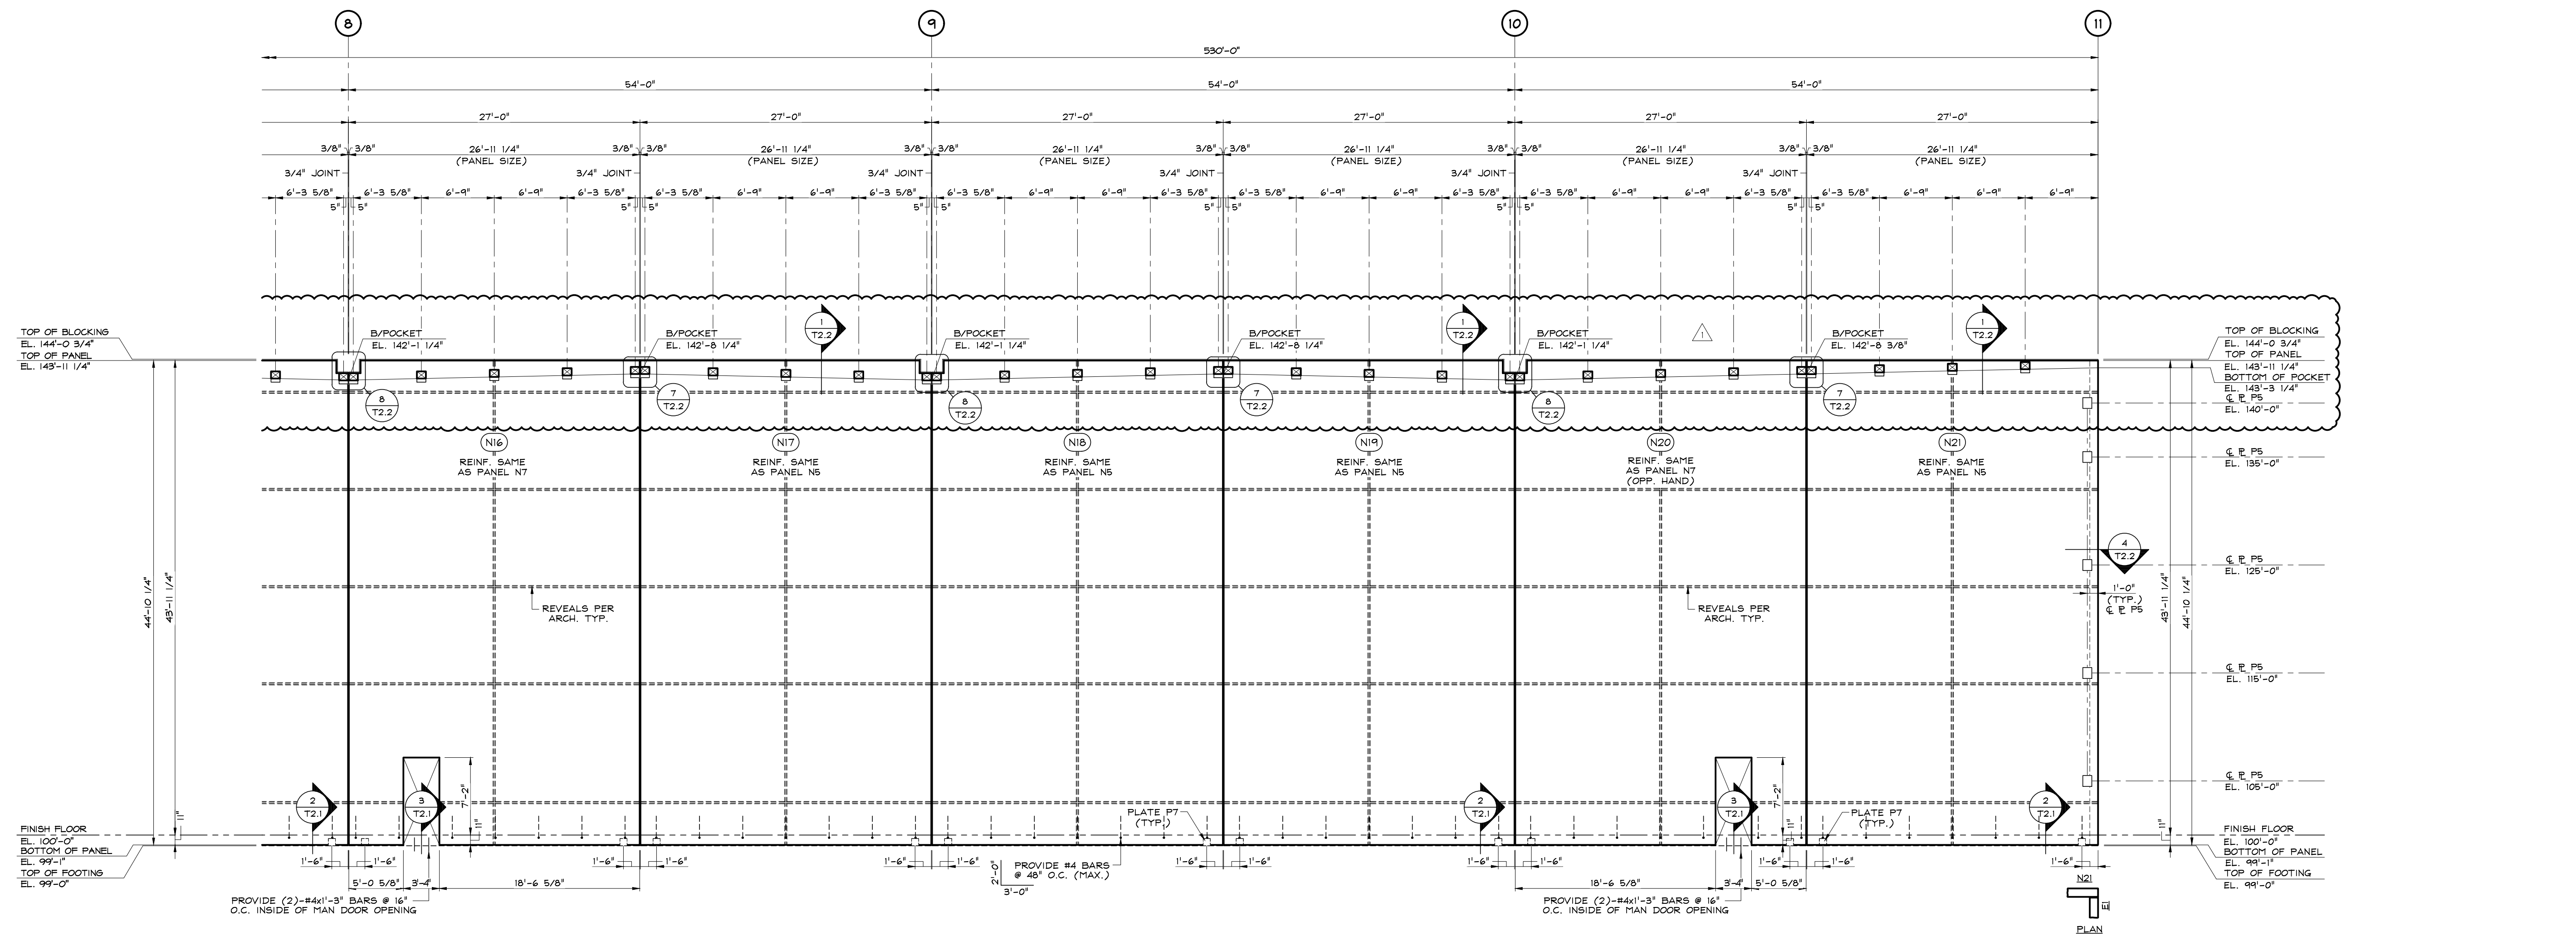

**NORTH ELEVATION (9 1/4" PANEL TYP. U.N.O.)**

SCALE: 1/8" = 1'-0"  
(LOOKING FROM INSIDE OF BUILDING ALONG COLUMN LINE A)

- NOTES:
1. VERIFY ALL PANEL AND OPENING DIMENSIONS W/GENERAL CONTRACTOR & ARCHITECT PRIOR TO CASTING PANELS W/DOORS AND WINDOWS.
  2. PROVIDE 1-#5 E.F. AROUND PERIMETER OF PANEL U.N.O.
  3. CONTINUE REINFORCING THROUGH KNOCK-OUT OPENINGS.
  4. BLOCKING AT TOP OF HALL TO REMAIN AFTER CONSTRUCTION OF PANELS.
  5. HORIZONTAL STEEL CONTINUES THROUGH PANEL LEGS AT ALL OPENINGS.

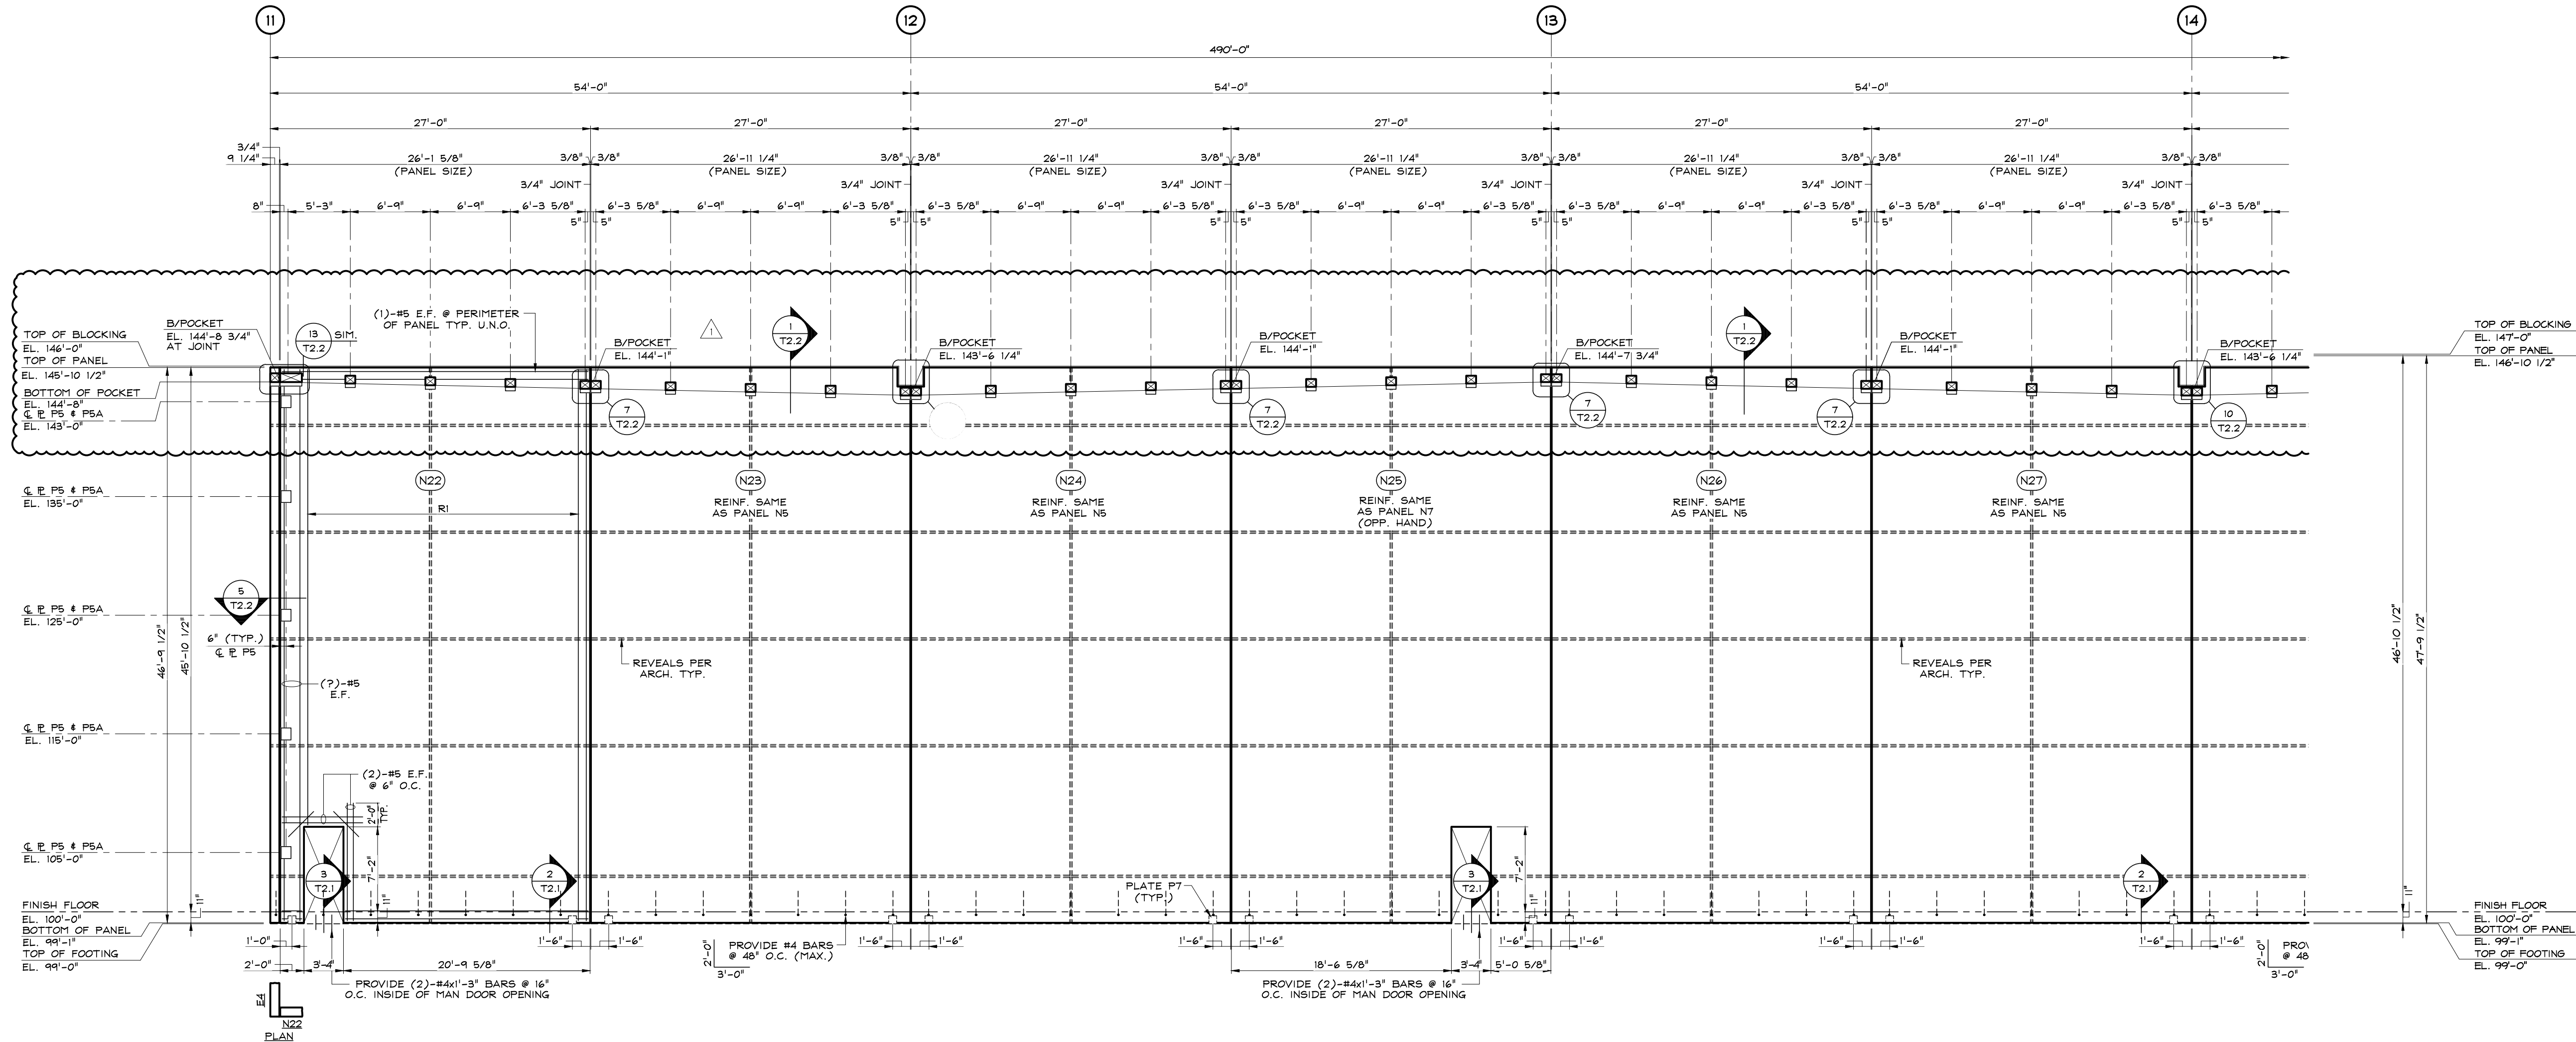

**NORTH ELEVATION (9 1/4" PANEL TYP. U.N.O.)**

SCALE: 1/8" = 1'-0"  
(LOOKING FROM INSIDE OF BUILDING ALONG COLUMN LINE C)

- NOTES:
1. VERIFY ALL PANEL AND OPENING DIMENSIONS W/GENERAL CONTRACTOR & ARCHITECT PRIOR TO CASTING PANELS W/DOORS AND WINDOWS.
  2. PROVIDE 1-#5 E.F. AROUND PERIMETER OF PANEL U.N.O.
  3. CONTINUE REINFORCING THROUGH KNOCK-OUT OPENINGS.
  4. BLOCKING AT TOP OF HALL TO REMAIN AFTER CONSTRUCTION OF PANELS.
  5. HORIZONTAL STEEL CONTINUES THROUGH PANEL LEGS AT ALL OPENINGS.

**REINFORCEMENT SCHEDULE**

R1	#5 BARS @ 10' O.C. VERT. #4 BARS @ 10' O.C. HORIZ.
R2	#5 BARS @ 8' O.C. VERT. #4 BARS @ 10' O.C. HORIZ.
R3	#5 BARS @ 12' O.C. VERT. #4 BARS @ 10' O.C. HORIZ.
R4	#4 BARS @ 12' O.C. E.F. VERT. #4 BARS @ 12' O.C. E.F. HORIZ.
R5	#5 BARS @ 10' O.C. VERT. #4 BARS @ 12' O.C. HORIZ.
R6	#4 BARS @ 12' O.C. VERT. #4 BARS @ 12' O.C. HORIZ.